


PLANTA BAIXA
ESCALA 1/2000







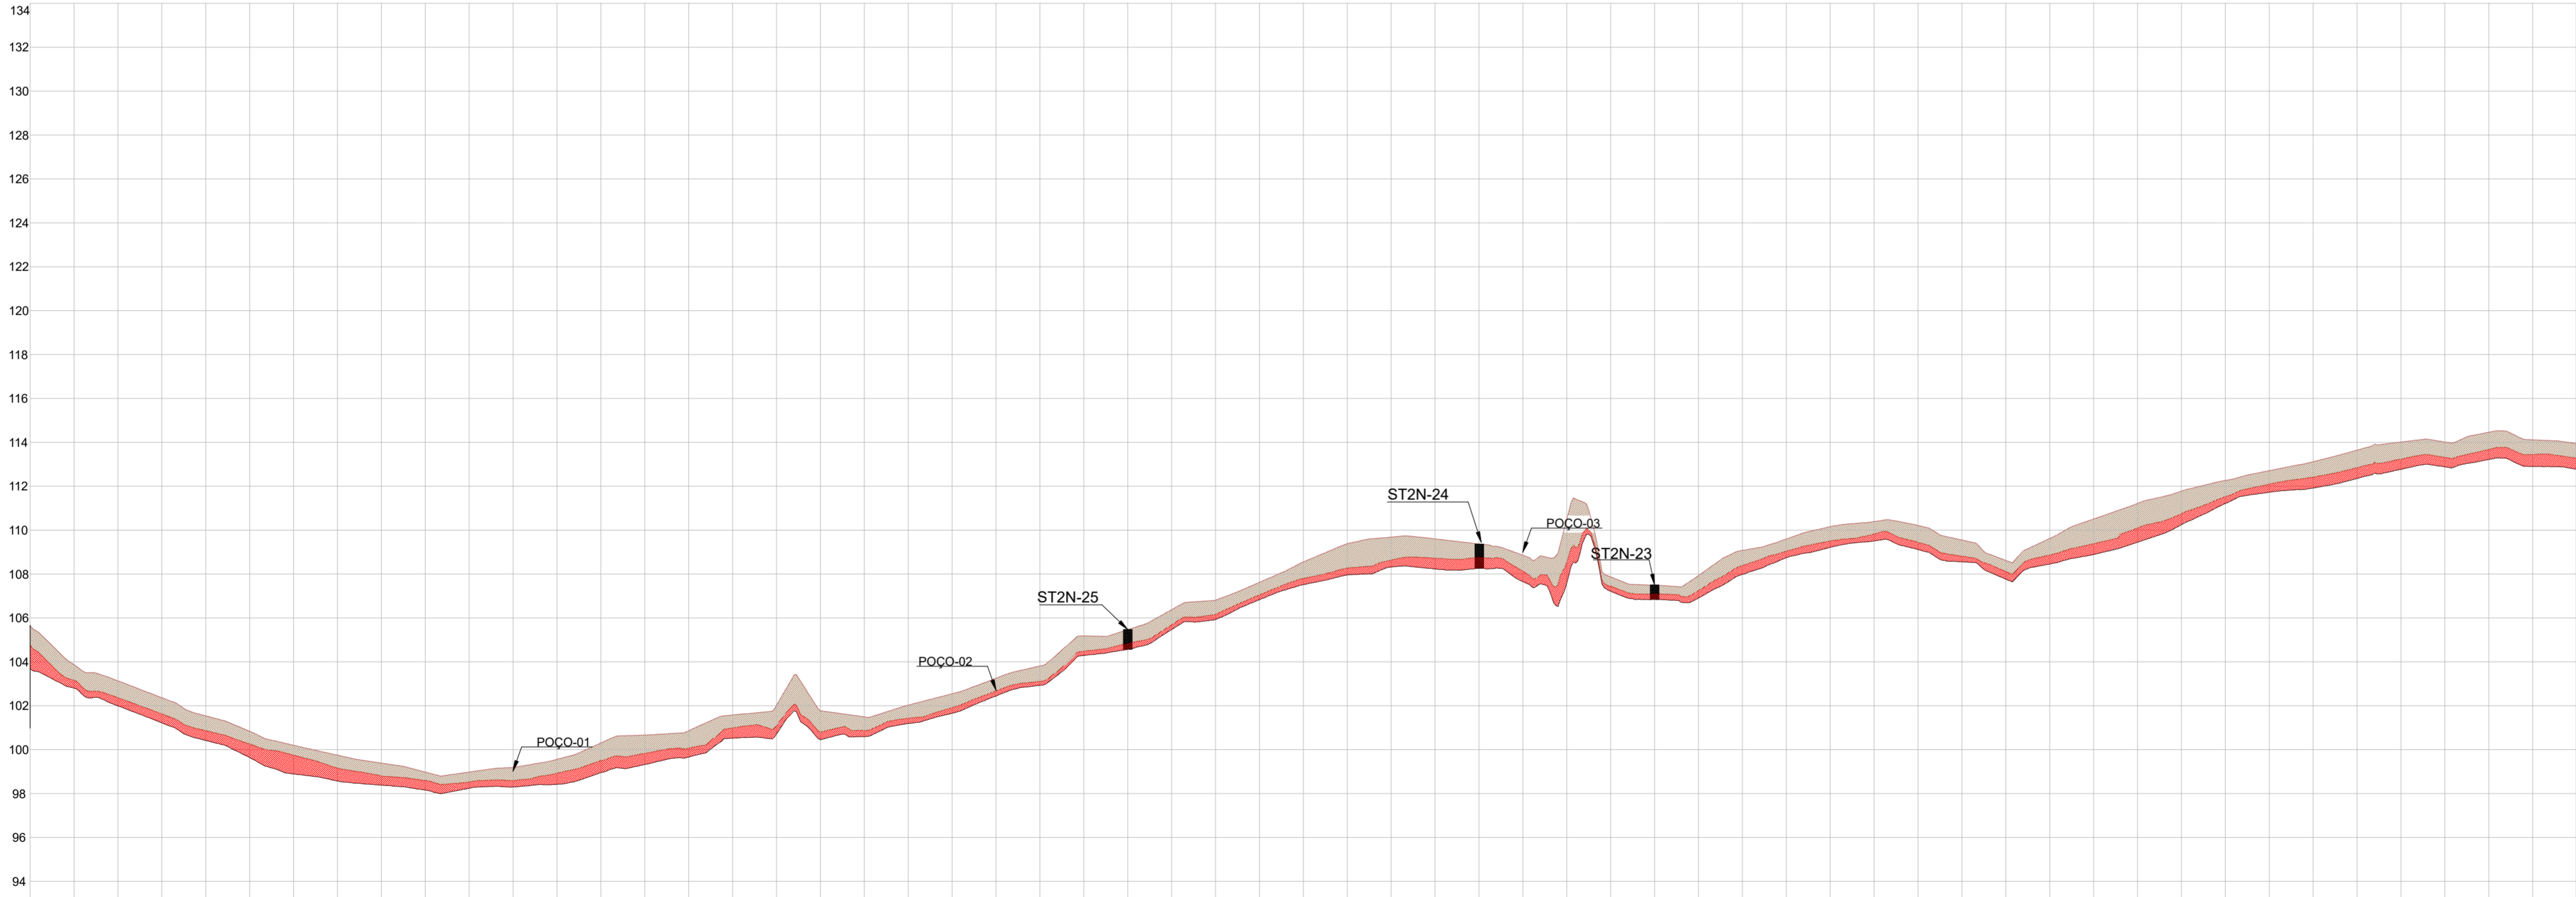









PERFIL LONGITUDINAL
ESCALA 1/2000

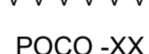

| |
|---|
| COTA TERRENO NATURAL | 103.580 | 104.740 | 103.680 | 103.870 | 103.130 | 102.370 | 101.540 | 100.840 | 100.200 | 99.750 | 99.750 | 99.390 | 98.990 | 98.990 | 98.530 | 98.990 | 98.190 | 98.300 | 98.600 | 99.190 | 98.420 | 98.930 | 99.560 | 98.960 | 99.510 | 100.310 | 99.330 | 98.830 | 100.670 | 99.660 | 100.070 | 100.860 | 100.520 | 100.390 | 101.590 | 100.710 | 101.110 | 102.020 | 100.450 | 103.800 | 101.770 | 100.590 | 103.970 | 101.490 | 101.190 | 101.430 | 102.030 | 101.660 | 101.920 | 102.550 | 102.440 | 102.670 | 103.250 | 102.530 | 103.110 | 103.810 | 104.290 | 104.480 | 105.180 | 104.570 | 104.850 | 105.470 | 105.470 | 105.690 | 105.380 | 105.930 | 106.170 | 106.810 | 106.830 | 107.040 | 107.620 | 107.520 | 107.800 | 108.550 | 107.560 | 108.270 | 109.380 | 108.320 | 108.640 | 109.690 | 108.230 | 108.720 | 109.600 | 108.270 | 108.770 | 109.370 | 107.660 | 108.130 | 108.860 | 107.590 | 108.540 | 110.490 | 107.220 | 107.440 | 107.870 | 106.650 | 107.100 | 107.500 | 106.910 | 107.250 | 107.930 | 107.590 | 108.390 | 109.080 | 108.750 | 109.040 | 109.600 | 109.220 | 109.510 | 110.160 | 109.510 | 109.830 | 110.390 | 109.110 | 109.440 | 110.210 | 108.560 | 108.810 | 109.550 | 107.770 | 108.120 | 108.620 | 108.450 | 108.870 | 109.620 | 108.890 | 109.380 | 110.510 | 109.450 | 110.100 | 111.220 | 110.250 | 110.760 | 111.760 | 111.220 | 111.530 | 112.270 | 111.730 | 112.100 | 112.710 | 111.520 | 112.420 | 113.120 | 112.350 | 112.840 | 113.640 | 112.770 | 113.230 | 114.010 | 112.880 | 113.310 | 114.010 | 113.220 | 113.660 | 114.460 | 112.900 | 113.440 | 114.110 | 112.770 | 113.940 |
| COTA MATERIAL DE 1ª CAT. | 103.580 | 104.740 | 103.680 | 103.870 | 103.130 | 102.370 | 101.540 | 100.840 | 100.200 | 99.750 | 99.750 | 99.390 | 98.990 | 98.990 | 98.530 | 98.990 | 98.190 | 98.300 | 98.600 | 99.190 | 98.420 | 98.930 | 99.560 | 98.960 | 99.510 | 100.310 | 99.330 | 98.830 | 100.670 | 99.660 | 100.070 | 100.860 | 100.520 | 100.390 | 101.590 | 100.710 | 101.110 | 102.020 | 100.450 | 103.800 | 101.770 | 100.590 | 103.970 | 101.490 | 101.190 | 101.430 | 102.030 | 101.660 | 101.920 | 102.550 | 102.440 | 102.670 | 103.250 | 102.530 | 103.110 | 103.810 | 104.290 | 104.480 | 105.180 | 104.570 | 104.850 | 105.470 | 105.470 | 105.690 | 105.380 | 105.930 | 106.170 | 106.810 | 106.830 | 107.040 | 107.620 | 107.520 | 107.800 | 108.550 | 107.560 | 108.270 | 109.380 | 108.320 | 108.640 | 109.690 | 108.230 | 108.720 | 109.600 | 108.270 | 108.770 | 109.370 | 107.660 | 108.130 | 108.860 | 107.590 | 108.540 | 110.490 | 107.220 | 107.440 | 107.870 | 106.650 | 107.100 | 107.500 | 106.910 | 107.250 | 107.930 | 107.590 | 108.390 | 109.080 | 108.750 | 109.040 | 109.600 | 109.220 | 109.510 | 110.160 | 109.510 | 109.830 | 110.390 | 109.110 | 109.440 | 110.210 | 108.560 | 108.810 | 109.550 | 107.770 | 108.120 | 108.620 | 108.450 | 108.870 | 109.620 | 108.890 | 109.380 | 110.510 | 109.450 | 110.100 | 111.220 | 110.250 | 110.760 | 111.760 | 111.220 | 111.530 | 112.270 | 111.730 | 112.100 | 112.710 | 111.520 | 112.420 | 113.120 | 112.350 | 112.840 | 113.640 | 112.770 | 113.230 | 114.010 | 112.880 | 113.310 | 114.010 | 113.220 | 113.660 | 114.460 | 112.900 | 113.440 | 114.110 | 112.770 | 113.940 |
| COTA MATERIAL DE 2ª CAT. | 103.580 | 104.740 | 103.680 | 103.870 | 103.130 | 102.370 | 101.540 | 100.840 | 100.200 | 99.750 | 99.750 | 99.390 | 98.990 | 98.990 | 98.530 | 98.990 | 98.190 | 98.300 | 98.600 | 99.190 | 98.420 | 98.930 | 99.560 | 98.960 | 99.510 | 100.310 | 99.330 | 98.830 | 100.670 | 99.660 | 100.070 | 100.860 | 100.520 | 100.390 | 101.590 | 100.710 | 101.110 | 102.020 | 100.450 | 103.800 | 101.770 | 100.590 | 103.970 | 101.490 | 101.190 | 101.430 | 102.030 | 101.660 | 101.920 | 102.550 | 102.440 | 102.670 | 103.250 | 102.530 | 103.110 | 103.810 | 104.290 | 104.480 | 105.180 | 104.570 | 104.850 | 105.470 | 105.470 | 105.690 | 105.380 | 105.930 | 106.170 | 106.810 | 106.830 | 107.040 | 107.620 | 107.520 | 107.800 | 108.550 | 107.560 | 108.270 | 109.380 | 108.320 | 108.640 | 109.690 | 108.230 | 108.720 | 109.600 | 108.270 | 108.770 | 109.370 | 107.660 | 108.130 | 108.860 | 107.590 | 108.540 | 110.490 | 107.220 | 107.440 | 107.870 | 106.650 | 107.100 | 107.500 | 106.910 | 107.250 | 107.930 | 107.590 | 108.390 | 109.080 | 108.750 | 109.040 | 109.600 | 109.220 | 109.510 | 110.160 | 109.510 | 109.830 | 110.390 | 109.110 | 109.440 | 110.210 | 108.560 | 108.810 | 109.550 | 107.770 | 108.120 | 108.620 | 108.450 | 108.870 | 109.620 | 108.890 | 109.380 | 110.510 | 109.450 | 110.100 | 111.220 | 110.250 | 110.760 | 111.760 | 111.220 | 111.530 | 112.270 | 111.730 | 112.100 | 112.710 | 111.520 | 112.420 | 113.120 | 112.350 | 112.840 | 113.640 | 112.770 | 113.230 | 114.010 | 112.880 | 113.310 | 114.010 | 113.220 | 113.660 | 114.460 | 112.900 | 113.440 | 114.110 | 112.770 | 113.940 |
| COTA MATERIAL DE 3ª CAT. | 103.580 | 104.740 | 103.680 | 103.870 | 103.130 | 102.370 | 101.540 | 100.840 | 100.200 | 99.750 | 99.750 | 99.390 | 98.990 | 98.990 | 98.530 | 98.990 | 98.190 | 98.300 | 98.600 | 99.190 | 98.420 | 98.930 | 99.560 | 98.960 | 99.510 | 100.310 | 99.330 | 98.830 | 100.670 | 99.660 | 100.070 | 100.860 | 100.520 | 100.390 | 101.590 | 100.710 | 101.110 | 102.020 | 100.450 | 103.800 | 101.770 | 100.590 | 103.970 | 101.490 | 101.190 | 101.430 | 102.030 | 101.660 | 101.920 | 102.550 | 102.440 | 102.670 | 103.250 | 102.530 | 103.110 | 103.810 | 104.290 | 104.480 | 105.180 | 104.570 | 104.850 | 105.470 | 105.470 | 105.690 | 105.380 | 105.930 | 106.170 | 106.810 | 106.830 | 107.040 | 107.620 | 107.520 | 107.800 | 108.550 | 107.560 | 108.270 | 109.380 | 108.320 | 108.640 | 109.690 | 108.230 | 108.720 | 109.600 | 108.270 | 108.770 | 109.370 | 107.660 | 108.130 | 108.860 | 107.590 | 108.540 | 110.490 | 107.220 | 107.440 | 107.870 | 106.650 | 107.100 | 107.500 | 106.910 | 107.250 | 107.930 | 107.590 | 108.390 | 109.080 | 108.750 | 109.040 | 109.600 | 109.220 | 109.510 | 110.160 | 109.510 | 109.830 | 110.390 | 109.110 | 109.440 | 110.210 | 108.560 | 108.810 | 109.550 | 107.770 | 108.120 | 108.620 | 108.450 | 108.870 | 109.620 | 108.890 | 109.380 | 110.510 | 109.450 | 110.100 | 111.220 | 110.250 | 110.760 | 111.760 | 111.220 | 111.530 | 112.270 | 111.730 | 112.100 | 112.710 | 111.520 | 112.420 | 113.120 | 112.350 | 112.840 | 113.640 | 112.770 | 113.230 | 114.010 | 112.880 | 113.310 | 114.010 | 113.220 | 113.660 | 114.460 | 112.900 | 113.440 | 114.110 | 112.770 | 113.940 |
| ESTAQUEAMENTO | 0 | 1 | 2 | 58 | |

| Nº | DATA | REVISÃO | EXECUTADO POR | APROVADO POR | CODEVASF ACEITO DATA | DESENHO DE REFERÊNCIA | NOTA: |
|----|----------|------------------------|---------------------|--------------|-------------------------|-----------------------|-------|
| 00 | AGO/2021 | EMIÇÃO INICIAL | ALEXANDRE VELÁSQUEZ | ANA PAULA | | | |
| 01 | MAR/2022 | ESTUDOS COMPLEMENTARES | ALEXANDRE VELÁSQUEZ | ANA PAULA | | | |
| | | | | | | | |
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LEGENDA:

-  CURVAS DE NÍVEL
-  PONTO DE SONDAGEM POR TRINCHEIRA EM PLANTA
-  MATERIAL DE 1º CATEGORIA
-  MATERIAL DE 2º CATEGORIA
-  MATERIAL DE 3º CATEGORIA
-  LINHA DE TERRENO NATURAL
-  LINHA DE TOPO EM ROCHA
-  POÇO -XX
-  ST(X)N-XX
-  MATERIAL DE 1º CATEGORIA
-  MATERIAL DE 2º CATEGORIA
-  MATERIAL DE 3º CATEGORIA
-  LINHA DE TERRENO NATURAL
-  LINHA DE TOPO EM ROCHA
-  POÇO DE INSPEÇÃO DO PROJETO BÁSICO
-  TRINCHEIRAS DOS ESTUDOS COMPLEMENTARES DO PROJETO EXECUTIVO

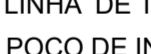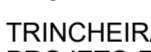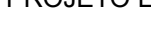

MINISTÉRIO DO DESENVOLVIMENTO REGIONAL – MDR
Companhia de Desenvolvimento dos Vales do São Francisco e do Parnaíba - CODEVASF

Contrato: CT.0.166.00. 2020 - PROJETO EXECUTIVO E ESTUDOS COMPLEMENTARES DOS SISTEMAS ADUTORES NA REGIÃO DO SERIDÓ NO ESTADO DO RIO GRANDE DO NORTE

Responsável Técnico: ANTONIO C. VIDON - CREA 2724/D - DF
Assinatura: [Signature]
Desenhista: VANILSON MONTEIRO
Assinatura: [Signature]

PROJETO EXECUTIVO

Assunto: ESTUDO GEOLÓGICO/GEOTÉCNICO
Sub-Assunto: MATERIAIS DE 1º, 2º E 3º CATEGORIAS
PLANTA BAIXA E PERFIL
EST. 0+0,00 A EST. 58+0,00

Desenho: SER-2N-PE-GEQ-001-R0.2
Prancha: 01/36
Revisão: R01
Data: MARÇO/2022
Escala: 1/2000 H - 1/200 V

